GENERAL NOTES

THESE DRAWINGS ARE THE PROPERTY OF THE ARCHITECT AND MAY BE REPRODUCED ONLY WITH THE WRITTEN PERMISSION OF THE ARCHITECT. AUTHORIZED REPRODUCTIONS MUST BEAR THE NAME OF THE ARCHITECT. COPYRIGHT 2023 BY CHESMORE/BUCK ARCHITECTURE. THESE DRAWINGS ARE FULLY PROTECTED BY FEDERAL AND STATE COPYRIGHT LAWS. ANY INFRINGEMEN WILL BE VIGOROUSLY PROSECUTED.

ALL CONSTRUCTION SHALL CONFORM TO THE 2015 INTERNATIONAL RESIDENTIAL CODE (IRC) AND BE IN ACCORDANCE WITH THE WASHINGTON STATE LAWS AND REGULATIONS AND VARIOUS CODES IMPOSED BY LOCAL AUTHORITIES.


CONTRACTOR TO VERIFY ALL DIMENSIONS AND STRUCTURAL MEMBER SIZES PRIOR TO CONSTRUCTION. CONTRACTOR TO INFORM ARCHITECT OF ANY DISCREPANCIES IN THE DRAWINGS OR FROM THE CODES. CONTRACTOR INITIATED CHANGES SHALL BE SUBMITTED IN WRITING TO THE ARCHTECT AND STRUCTURAL ENGINEER FOR APPROVAL PRIOR TO FABRICATION OR CONSTRUCTION. CHANGES SHOWN ON THE DRAWING ONLY WILL NOT SATISFY THIS REQUIREMENT.

CONTRACTOR SHALL BE RESPONSIBLE FOR ALL REQUIRED SAFETY PRECAUTIONS AND THE METHODS, TECHNIQUES, SEQUENCES OR PROCEDURES REQUIRED TO PERFORM HIS WORK.


ALL STUCTURAL SYSTEMS SUCH AS WOOD TRUSSES WHICH ARE TO BE COMPOSED OF COMPONENTS TO BE FIELD ERECTED SHALL BE SUPERVISED BY THE SUPPLIER DURING MANUFACTURING, DELIVERY, HANDLING, STORAGE AND ERECTION IN ACCORDANCE WITH INSTRUCTIONS PREPARED BY THE SUPPLIER.

THE CONTRACTOR IS RESPONSIBLE FOR NOTIFYING THE ARCHITECT IF UNUSUAL, UNFORESEEABLE, OR UNEXPECTED SUBSURFACE CONDITIONS ARE ENCOUNTERED.

BECAUSE THE CONTRACT DOCUMENTS ARE COMPLEMENTARY, THE CONTRACTOR SHALL, BEFORE STARTING EACH PORTION OF THE WORK, CAREFULLY STUDY AND COMPARE THE VARIOUS CONTRACT DOCUMENT RELATIVE TO THAT PORTION OF THE WORK, AS WELL AS THE INFORMATION PROVIDED BY THE OWNER, SHALL TAKE FIELD MEASUREMENTS OF ANY EXISTING CONDITIONS RELATED TO THAT PORTION OF THE WORK AND SHALL OBSERVE ANY CONDITIONS AT THE SITE AFFECTING IT. THESE OBLIGATIONS ARE FOR THE PURPOSE OF FACILITATING COORDINATION AND CONSTRUCTION BY THE CONTRACTOR. THE CONTRACTOR SHALL REPORT TO THE ARCHITECT ANY ERRORS, INCONSISTENCIES, OR OMMISSIONS DISCOVERED BY OR MADE KNOWN TO THE CONTRACTOR AS A REQUEST FOR INFORMATION IN SUCH FORM AS THE ARCHITECT MAY REQUIRE. THE CONTRACTOR'S REVIEW IS MADE IN THE CONTRACTOR'S CAPACITY AS A CONTRACTOR AND NOT AS A LICENSED DESIGN PROFESSIONAL.

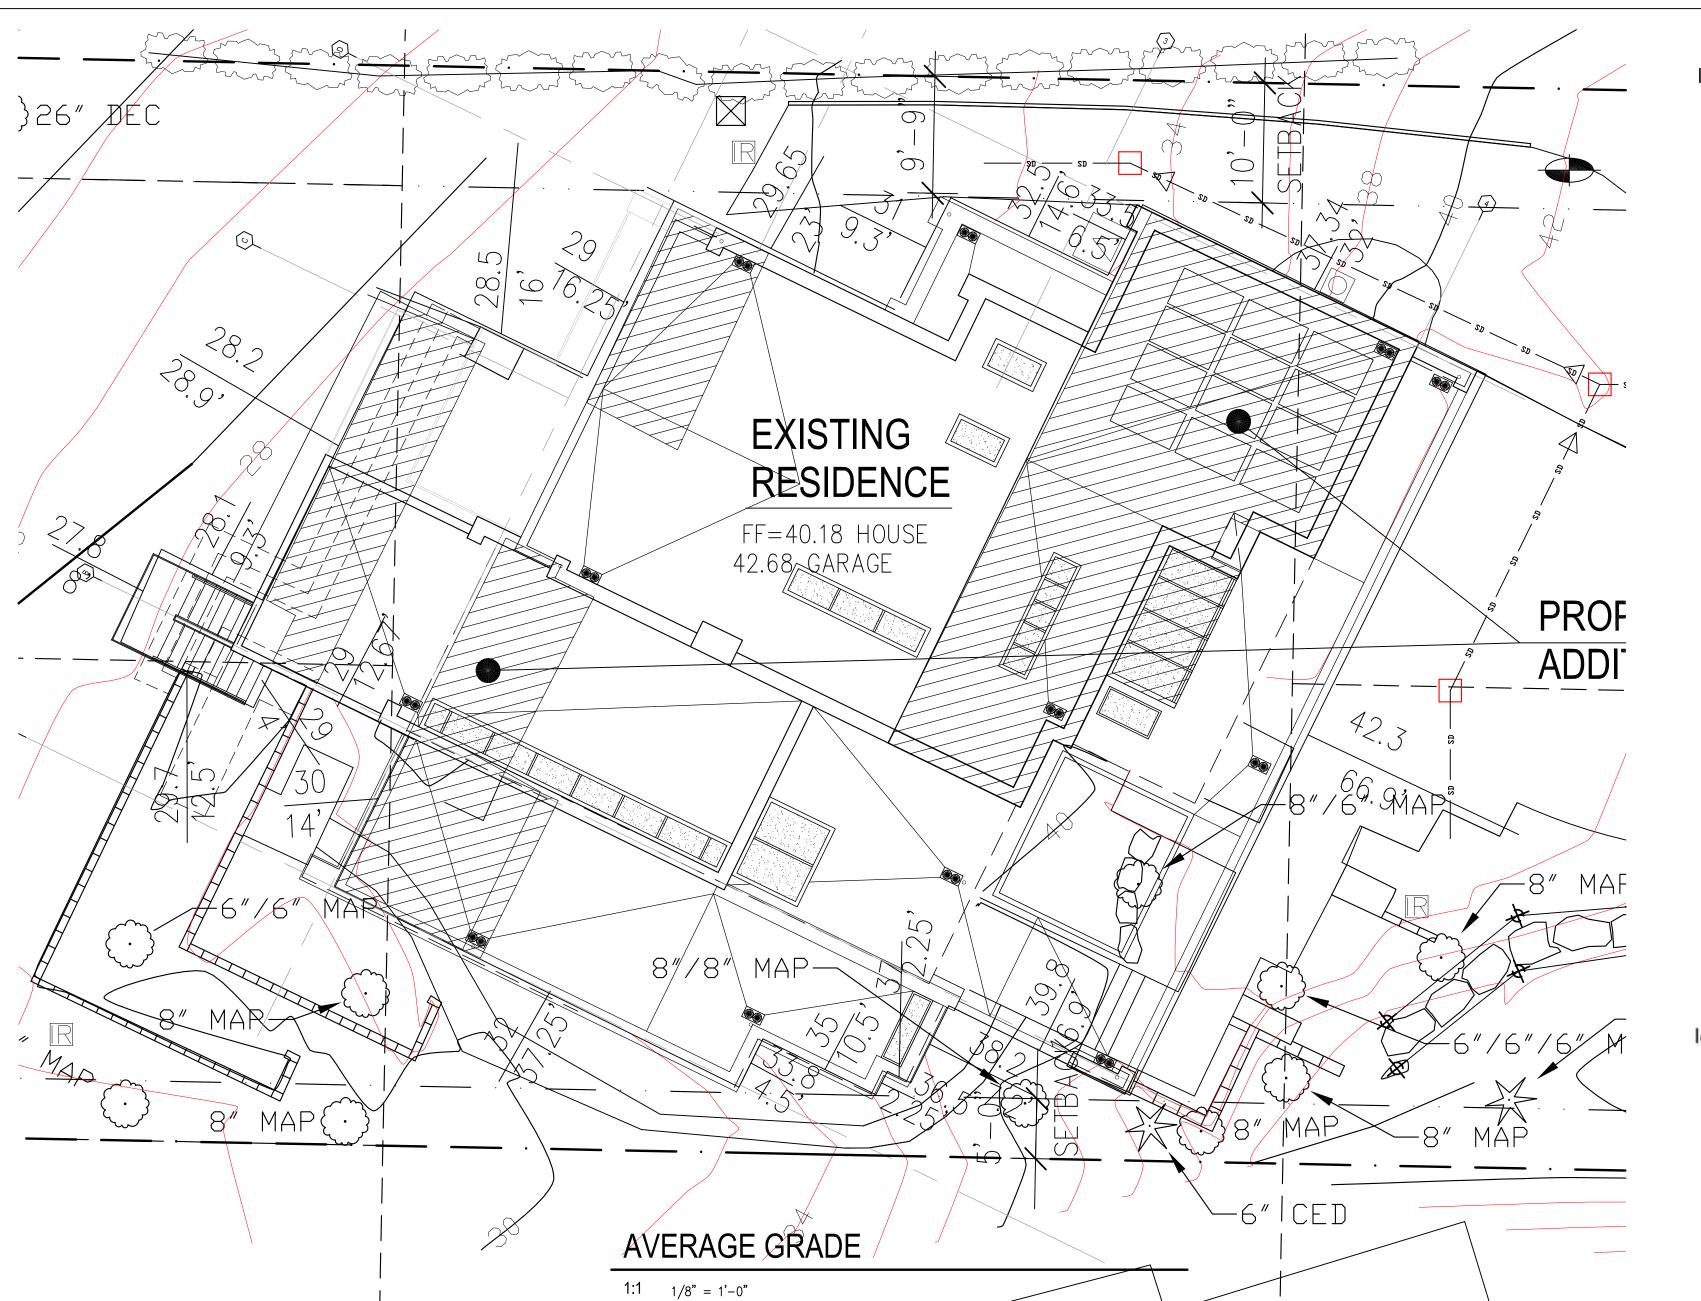

& VAC N 40 FT OF 16 THRU 22 & VAC S 50 FT OF 9 THRU 15 & VAC ST ADJ IN BLK 2 LOT COVERAGE elevation axb 37.34 1194.88 LOT COVERAGE: HOUSE W/ ADDITIONS 474.5 STRUCTURAL TOTAL 288.3 SPORT COURT 681.95 DRIVING SURFACES STEPPING STONES & ROCKERIES 40% ALLOWABLE LOT COVERAGE OR 17,119 S.F **GROSS FLOOR AREA** MAIN FLOOR UPPER FLOOR ALLOWABLE GROSS FLOOR AREA 82.125 HIGH POINT 80'-LOW POINT 18'=62' DIFFERENCE 62'/438.3' HORIZONTAL DISTANCE*100=12.8% LOT SLOPE 38.2 275.04 FIRE SPRINKLERS 39.8 672.62 42.3 2829.87 WILL REQUIRE A SEPARATE FIRE PERMIT. 342.1 11645.1

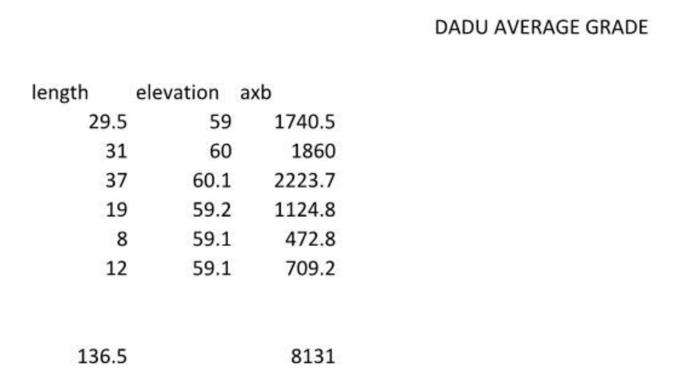

59.57 average grade

34.04 average grade

WALL SEGMENT # LENGTH % COVERAGE SEGMENT LENGTH 0.44 17.6 2.2 0.44 13.78 4.24 0.53 0.53 3.18 4.9 1.44 2.52 0.18 1.5 0.27 4.32 3.78 251 70.84 SEGMENT L/TOTAL L 0.282231076 BASEMENT FLOOR AREA FLOOR AREA 639.5356175

1" = 20'

PROJECT NOTES

PROPOSED ADDITION TO EXISTING RESIDENCE AND NEW ADU/GARAGE

OWNERS

STEVE KAO & HUI HONG 21722 CHINOOK ROAD WOODWAY, WA 98020

ZONING

PROPERTY TAX ACCT#

PROPERTY TAX ACCOUNT NUMBER: 294890-0015

LEGAL DESCRIPTION GROVELAND PARK ADD VAC 3-4 & S 10 FT OF 2 & SH LDS ADJ & VAC ST ADJ IN BLK 22

TOTAL LOT AREA: 42,797 S.F. NET LOT AREA 39,844 S.F. 5,266 S.F.

1,108 S.F. 143 S.F. 6,517 S.F. 1,950 S.F. 6,766 S.F.

15,233 S.F

3,916 S.F.

1,908 S.F.

HARDSCAPE MAX. ALLOWED 9% OF 42,797 S.F. = 3,852 S.F.

1,952 S.F. 8,416 S.F. 12,000 S.F.

LOT SLOPE CALCULATION

PROVIDE A NFPA 13D FIRE SPRINKLER SYSTEM THROUGHOUT THE MAIN HOUSE. THIS SYSTEM

PROVIDE THE DADU WITH A NFPA 13D MONITORED FIRE ALARM SYSTEM.

MERCER ISLAND COVER SHEET 1.0 SITE PLAN 0.0 SITE SURVEY

C-1 CSWPP PLAN C-2 DRAINAGE PLAN

C-3 DETAILS 2.0 LOWER FLOOR DEMOLITION PLAN

MAIN FLOOR DEMOLITION PLAN 2.2 UPPER FLOOR DEMOLITION PLAN

3.0 LOWER FLOOR PLAN MAIN FLOOR PLAN 3.2 UPPER FLOOR PLAN

4.0 SCHEDULES

4.1 SCHEDULES

4.2 DETAILS 5.0 EXTERIOR ELEVATIONS EXTERIOR ELEVATIONS

6.0 BUILDING SECTIONS

6.1 BUILDING SECTIONS

6.2 BUILDING SECTIONS 6.3 WALL SECTIONS

7.0 INTERIOR ELEVATIONS INTERIOR ELEVATIONS

7.2 INTERIOR ELEVATIONS

7.3 INTERIOR ELEVATIONS 7.4 INTERIOR ELEVATIONS

7.5 INTERIOR ELEVATIONS 7.6 INTERIOR ELEVATIONS

7.7 INTERIOR ELEVATIONS 7.8 INTERIOR ELEVATIONS

7.9 INTERIOR ELEVATIONS

E.1 LOWER FLOOR ELECTRICAL PLAN

E.2 MAIN FLOOR ELECTRICAL PLAN E.3 UPPER FLOOR ELECTRICAL PLAN

S.1 FOUNDATION PLAN

S.2 MAIN FLOOR FRAMING PLAN

S.3 UPPER FLOOR/ LOWER ROOF FRAMING PLAN

S.4 ROOF FRAMING PLAN

S1.0 GENERAL STRUCTURAL NOTES

S1.1 GENERAL STRUCTURAL NOTES

S1.2 GENERAL STRUCTURAL NOTES

S3.0 DETAILS

S3.1 DETAILS

S4.0 TYPICAL WOOD DETAILS

S4.1 TYPICAL WOOD DETAILS

S4.2 FLOOR DETAILS S4.3 DECK DETAILS

S4.4 WOOD DETAILS

S4.5 PARAPET AND FLAT ROOF DETAILS S5.0 STEEL DETAILS S6.0 WOOD AND STEEL DETAILS

DADU PLANS 2.0 FLOOR PLANS/FRAMING PLANS

ELECTRICAL PLANS

SCHEDULES AND NOTES 3.0 EXTERIOR ELEVATIONS/SECTIONS 3.1 DETAILS

SITE PLAN

Sheet No. 2222 Project No. 6/7/23